CITY OF RICHMOND, VIRGINIA DEPARTMENT OF PUBLIC WORKS ENGINEERING & TECHNICAL SERVICES

PROPOSED BRIDGE REPLACEMENT RTE. 360 OVER MANCHESTER CANAL VDOT PROJECT NUMBER: 0360-127-035, P101, C501, B613 **UPC NO. 113290**


INDEX OF SHEETS

SHEET TITLE

SHEET NO.


TITLE SHEET

BRIDGE	
PLAN AND DEVELOPED SECTION	
SEQUENCE OF CONSTRUCTION	S2–S3
TRANSVERSE SECTION	
ABUTMENTS	-
CONCRETE BARRIER	00

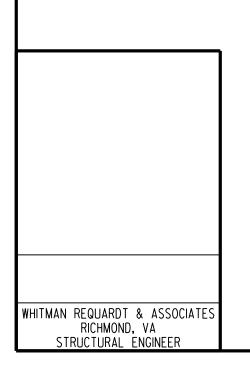



MAY 2021

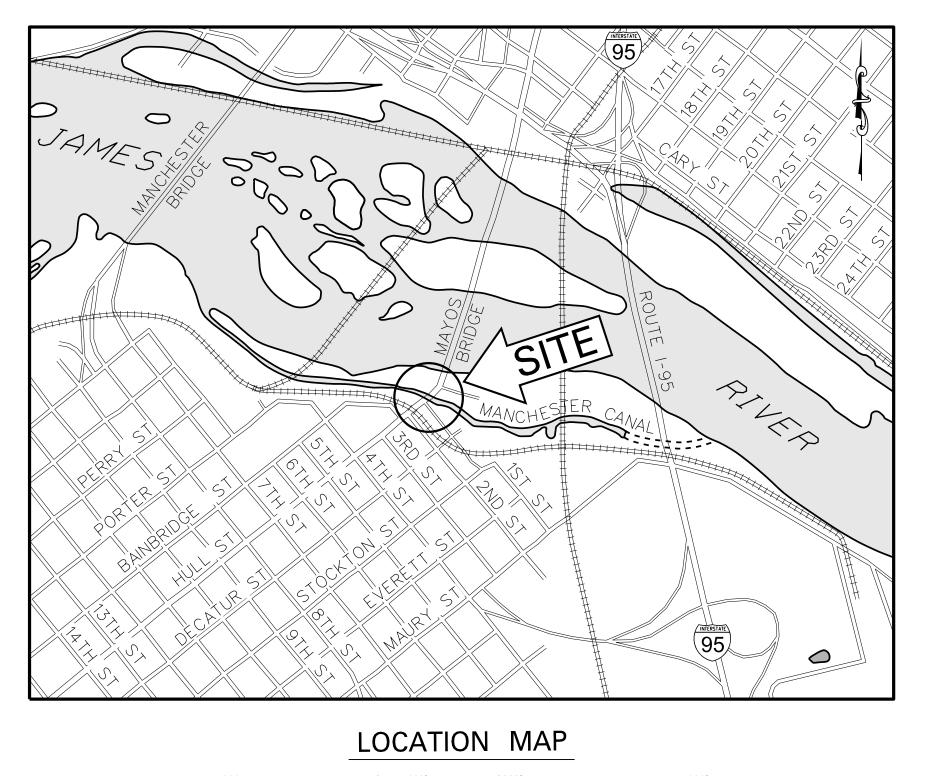

GRAPHIC SCALE

1″ = 1000′

PRELIMINARY PLANS
THESE PLANS NOT TO BE USED FOR CONSTRUCTION



CITY OF RICHMOND

	APPROVED FOR CONSTRUCTION					
DATE	SURVEYS SUPERINTENDENT					
DATE	PROJECT MANAGER					
DATE	MAINTENANCE ENGINEER					
DATE	CITY TRAFFIC ENGINEER					
DATE	CAPITAL PROJECTS ADMINISTRATOR					
DATE	CITY ENGINEER					
DATE	DIRECTOR OF PUBLIC WORKS					

REVISIONS


١0.	DATE	COMMENTS



CITY of RICHMOND

DEPARTMENT OF PUBLIC WORKS **RICHMOND, VIRGINIA**

DRAWING NO: X-XXXXX

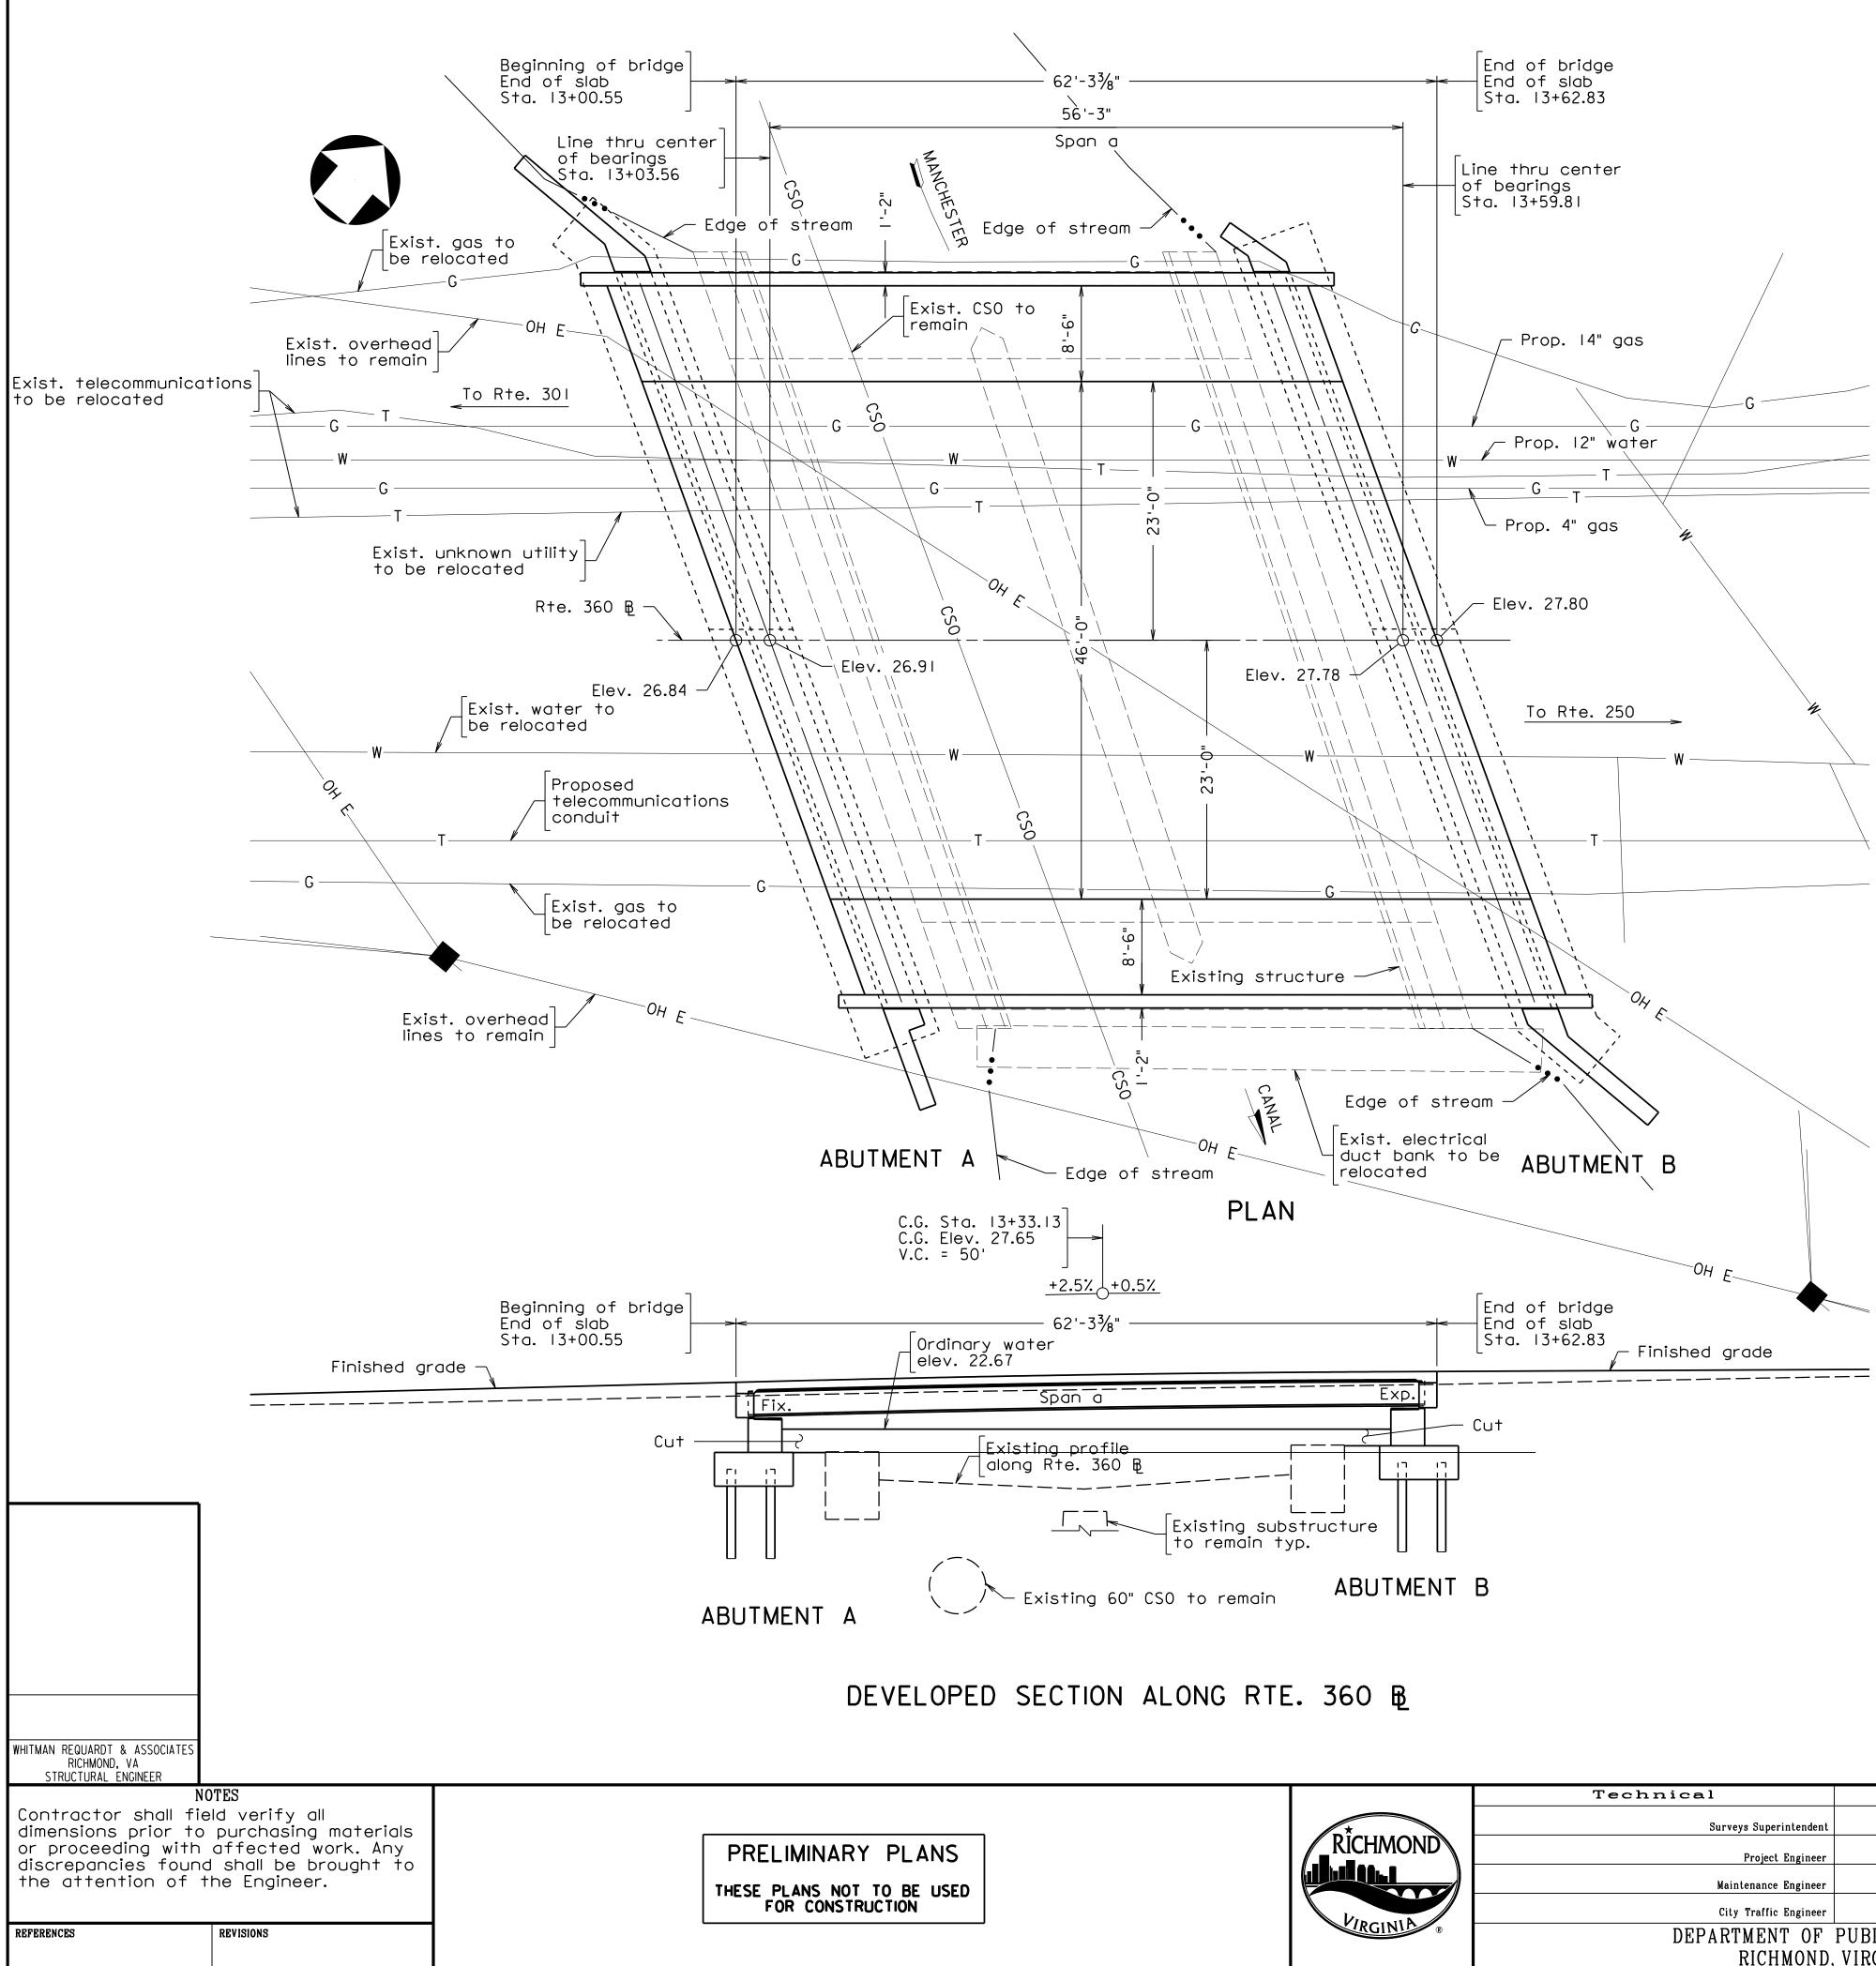

		Technical	Adminis	trative
*		Surveys Superintendent		
	MOND	Project Engineer		Capital Project Administrator
		Maintenance Engineer		Deputy Director for Transportation / Public Works
		City Traffic Engineer		Director of Public Works
	INIC ®	DEPARTMENT OF		
		RICHMOND,	VIRGINIA	

GENERAL NOTES:

Width: 8'-6" sidewalk, 46'-0" face-to-face of curbs, 8'-6" sidewalk. Overall width 63'-0" face-to-face of rails.

Span layout: 62'-3" single steel plate girder span.

Capacity: HL-93 loading (superstructure)

Drainage area: x.x sq. mi.

Specifications:

Construction: Virginia Department of Transportation Road and Bridge Specifications, 2020.

Design: AASHTO LRFD Bridge Design Specifications, 8th Edition, 2017; and VDOT Modifications.

All construction and materials shall conform with the latest standards and specifications of the Virginia Department of Transportation (VDOT), except as noted on the plans.

The Contractor shall be responsible for obtaining all necessary permits and or agreements from the City of Richmond before beginning construction.

These plans are incomplete unless accompanied by the Supplemental Specifications and Special Provisions included in the contract documents.

This project is to be constructed in accordance with the Virginia Department of Transportation Work Area Protection Manual, August 2011 and latest revisions.

The Contractor shall be thoroughly familiar with the plans and the existing structure, including the verification of all the existing dimensions before proceeding with the repairs. Dimensions of existing structure were taken from field measurements and the Bridge Safety Inspection Report. Discrepancies between field conditions and these plans shall be brought to the attention of the Engineer before proceeding with affected work.

All structural steel, including bearings, shall be ASTM A709 Grade 50CR and shall be unpainted.

ASTM A709 Grade 50CR shall conform to the requirements specified in the Special Provision for Corrosion Resistant Steel Plate Girders.

Concrete in superstructure, barrier and integral backwalls shall be Low Shrinkage Class A4 Modified Lightweight in accordance with Section 217.12(a); in substructure shall be Class A3.

Deformed reinforcing bars shall conform to ASTM A615, Grade 60. All reinforcing bar dimensions on the detailed drawings are to centers of bars except where otherwise noted and are subject to fabrication and construction tolerances.

Bridge No. of existing bridge is 1858. No plans available.

All welding shall be executed in accordance with Section 407.04 and 426.03 of the VDOT Specifications.

The Contractor shall be responsible for protecting existing utilities and shall repair them at no additional cost to the City, if damaged.


Any deviations from the approved plans and/or standards and specifications must be approved by the Engineer in writing, prior to the start of affected work.


The existing structure is designated a Type B structure in accordance with Sec. 411.

B.M.:


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DESIGN BY: DRAWN BY: CHECKED BY:	WRA	REVIEWED B	Y	FIELD N	OTES	SCALE AS NOTED	DATE May 2021	SHEET	S1	drawing no. X—XXXXX

	'-3" → < 6'-6" →	65'-7" ±				
		25'-0 ^l ∕₂"±	25'-0 R†e. 360 ₽ 1	/2"±		
			EXISTING			
	<u><</u> 6'-8"<	31'-5"	'-3" -> -> -> -> -> -> ->9"	3 '-7"		
		Single face concrete barrier service typ.				
			STAGE I 65'-4"			
	<pre>6'-8"</pre>	23'-0" concrete ice typ. L	- 49'-0" 3'-0" - Rte. 360 B	Face of curb		
	Letter John Strand Stra	Da. @ 9'-0" = 27'-0"	T T 4 spa. @ STAGE 2	I 8'-4" = 33'-4" —		
WHITMAN REQUARDT & ASSOCIATES RICHMOND, VA STRUCTURAL ENGINEER NOTES		SEQUENCE	E OF CONSTRUCTION Scale: ¹ / ₄ " = 1' Technical	Administrative		
Contractor shall field verify all dimensions prior to purchasing materials or proceeding with affected work. Any discrepancies found shall be brought to the attention of the Engineer. REFERENCES REVISIONS	PRELIMINARY PLANS THESE PLANS NOT TO BE USED FOR CONSTRUCTION	RÎCHMOND VIRGINIA ®	Surveys Superintendent Project Engineer Maintenance Engineer City Traffic Engineer DEPARTMENT OF PUBLI RICHMOND, VIRGI	Capital Project Administrator Deputy Director for Transportation / Public Works Director of Public Works C WORKS NIA		

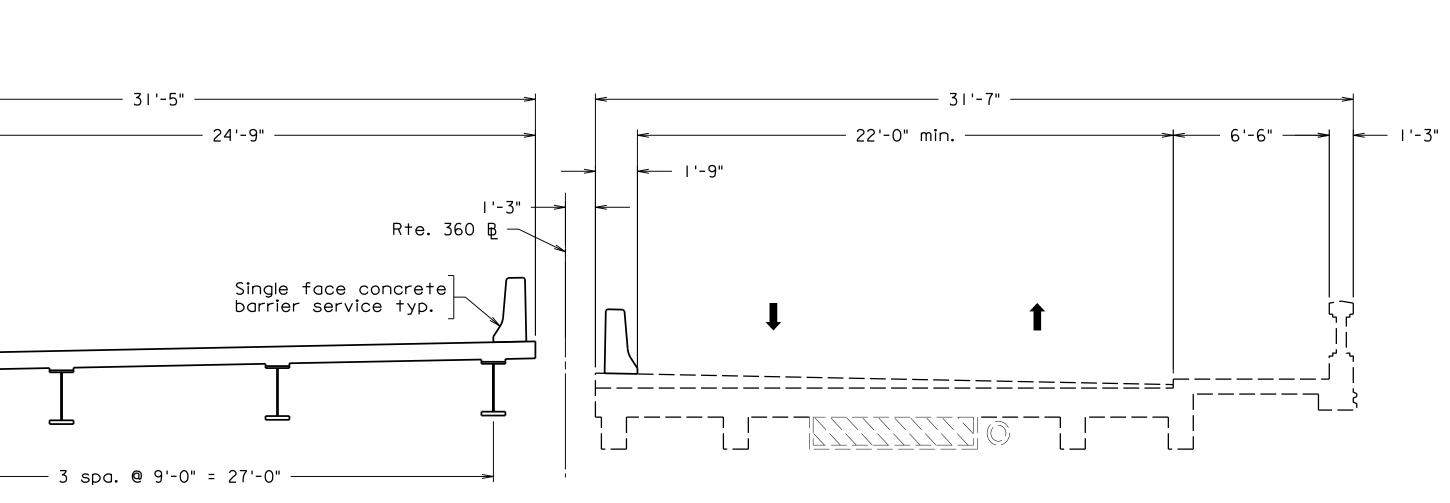


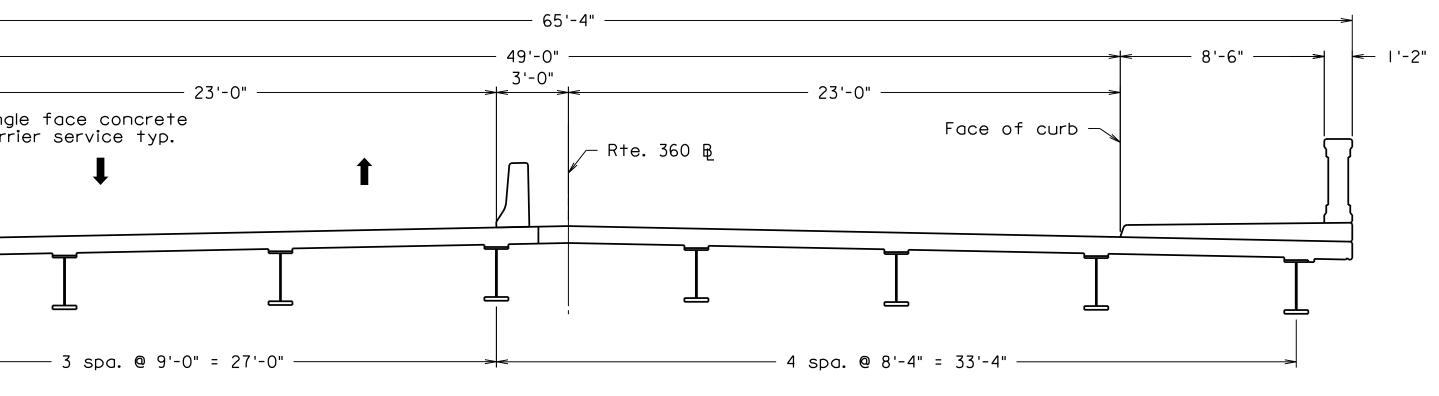


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	Technical	Administrative		360 01	VED MAN	СПЕСТІ	ER CANAL	
	Surveys Superintendent							
		Conital Project Administrator	I SEQUEN	CE	$\cap F$ ($^{\gamma}$ () \mathbb{N}^{r}	STRI($\gamma TION$
	Project Engineer	Capital Project Administrator Deputy Director for Transportation / Public Works					\mathcal{O}	
	Maintenance Engineer	Transportation / Public Works	4	~	1 ()			
Kinguyia	City Traffic Engineer	Director of Public Works		-		\sim		
VIRGINIA ®	DEPARTMENT OF PUB	BLIC WORKS	DESIGN BY: WRA REVIEWED BY DRAWN BY: WRA	FIELD NOTES	SCALE	DATE	SHEET	DRAWING NO.
	RICHMOND, VIR	GINIA	CHECKED BY: WRA		AS NOTED	MAY 2021	N K	X-XXXXX
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	l'-2"	Face of curb Single face concrete barrier service 3 spa. @ 9'-0" = 27'-0"	Rte. 360 B	5'-0" Face of curb I I J J J J J J J J J J J J J J J J J
	I'-2" - 8'-6"	23'-0" Face of curb	Rte. 360 ₪	Face of curb 1 1 2'-0" Face of curb 1 2 3'-4" 5. @ 8'-4" = 33'-4"
WHITMAN REQUARDT & ASSOCIATES RICHMOND, VA STRUCTURAL ENGINEER NOTES Contractor shall field verify all dimensions prior to purchasing materials or proceeding with affected work. Any discrepancies found shall be brought to the attention of the Engineer. REFERENCES REVISIONS 03 Sequence of Construction - Steldam	PRELIMINARY PLANS THESE PLANS NOT TO BE USED FOR CONSTRUCTION		Technical Surveys Superintendent Project Engineer Maintenance Engineer City Traffic Engineer DEPARTMENT OF PU RICHMOND, V	Administrative Capital Project Administrator Deputy Director for Transportation / Public Works Director of Public Works UBLIC WORKS /IRGINIA

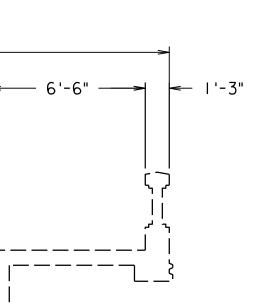


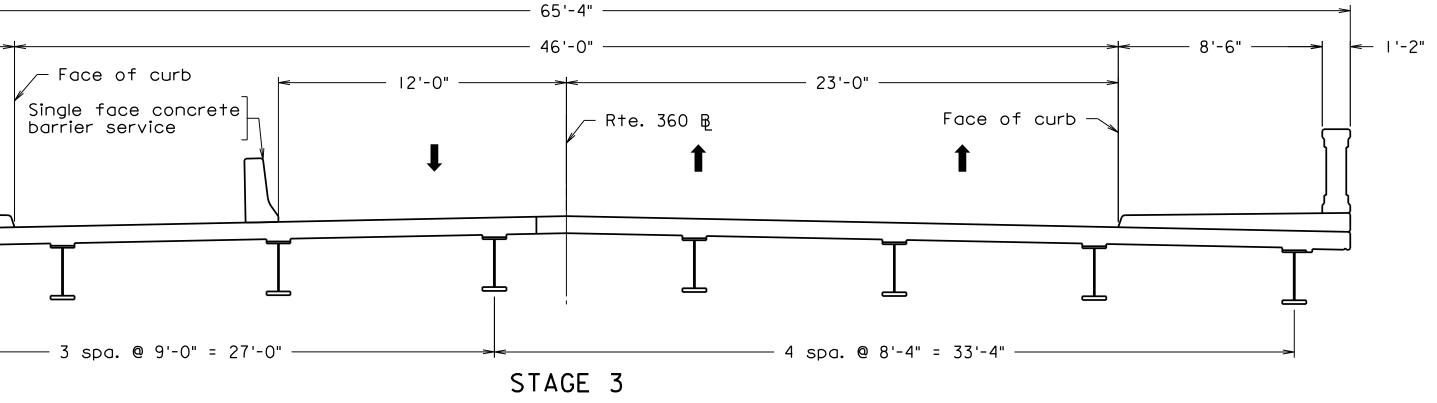


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Scale: ^I /	4"	=	1'	

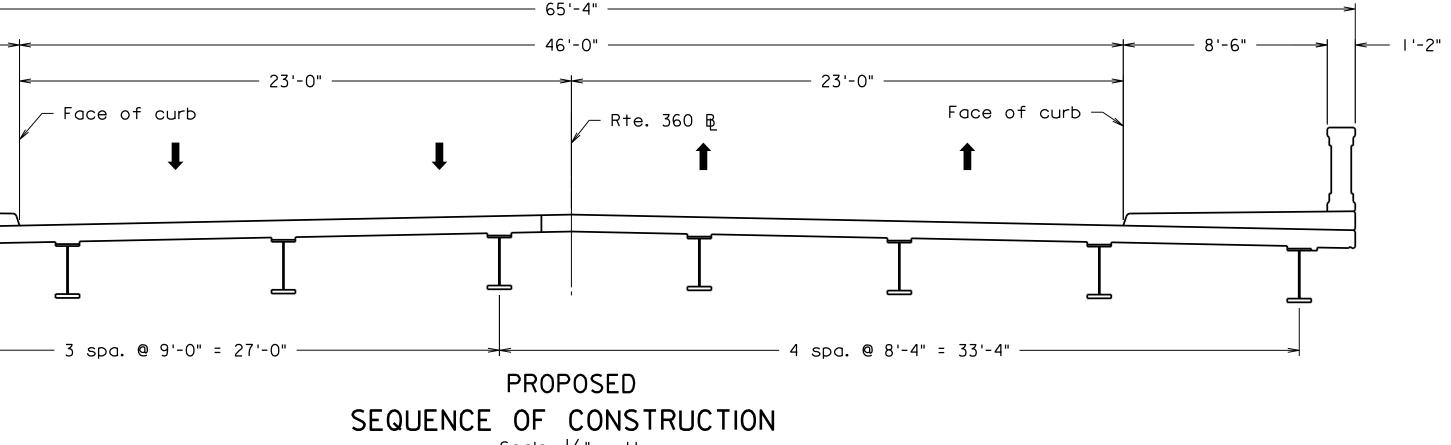	_ /	RTE	. 360 OVI	ER MAN	CHESTE	ER CA	ANAL	
	SEQUENCE OF CONSTRUCTION							
s								
	DESIGN BY: WRA Drawn by: WRA Checked by: WRA	REVIEWED BY	FIELD NOTES	SCALE AS NOTED	DATE May 2021	SHEET	S3	drawing no. X—XXXXX



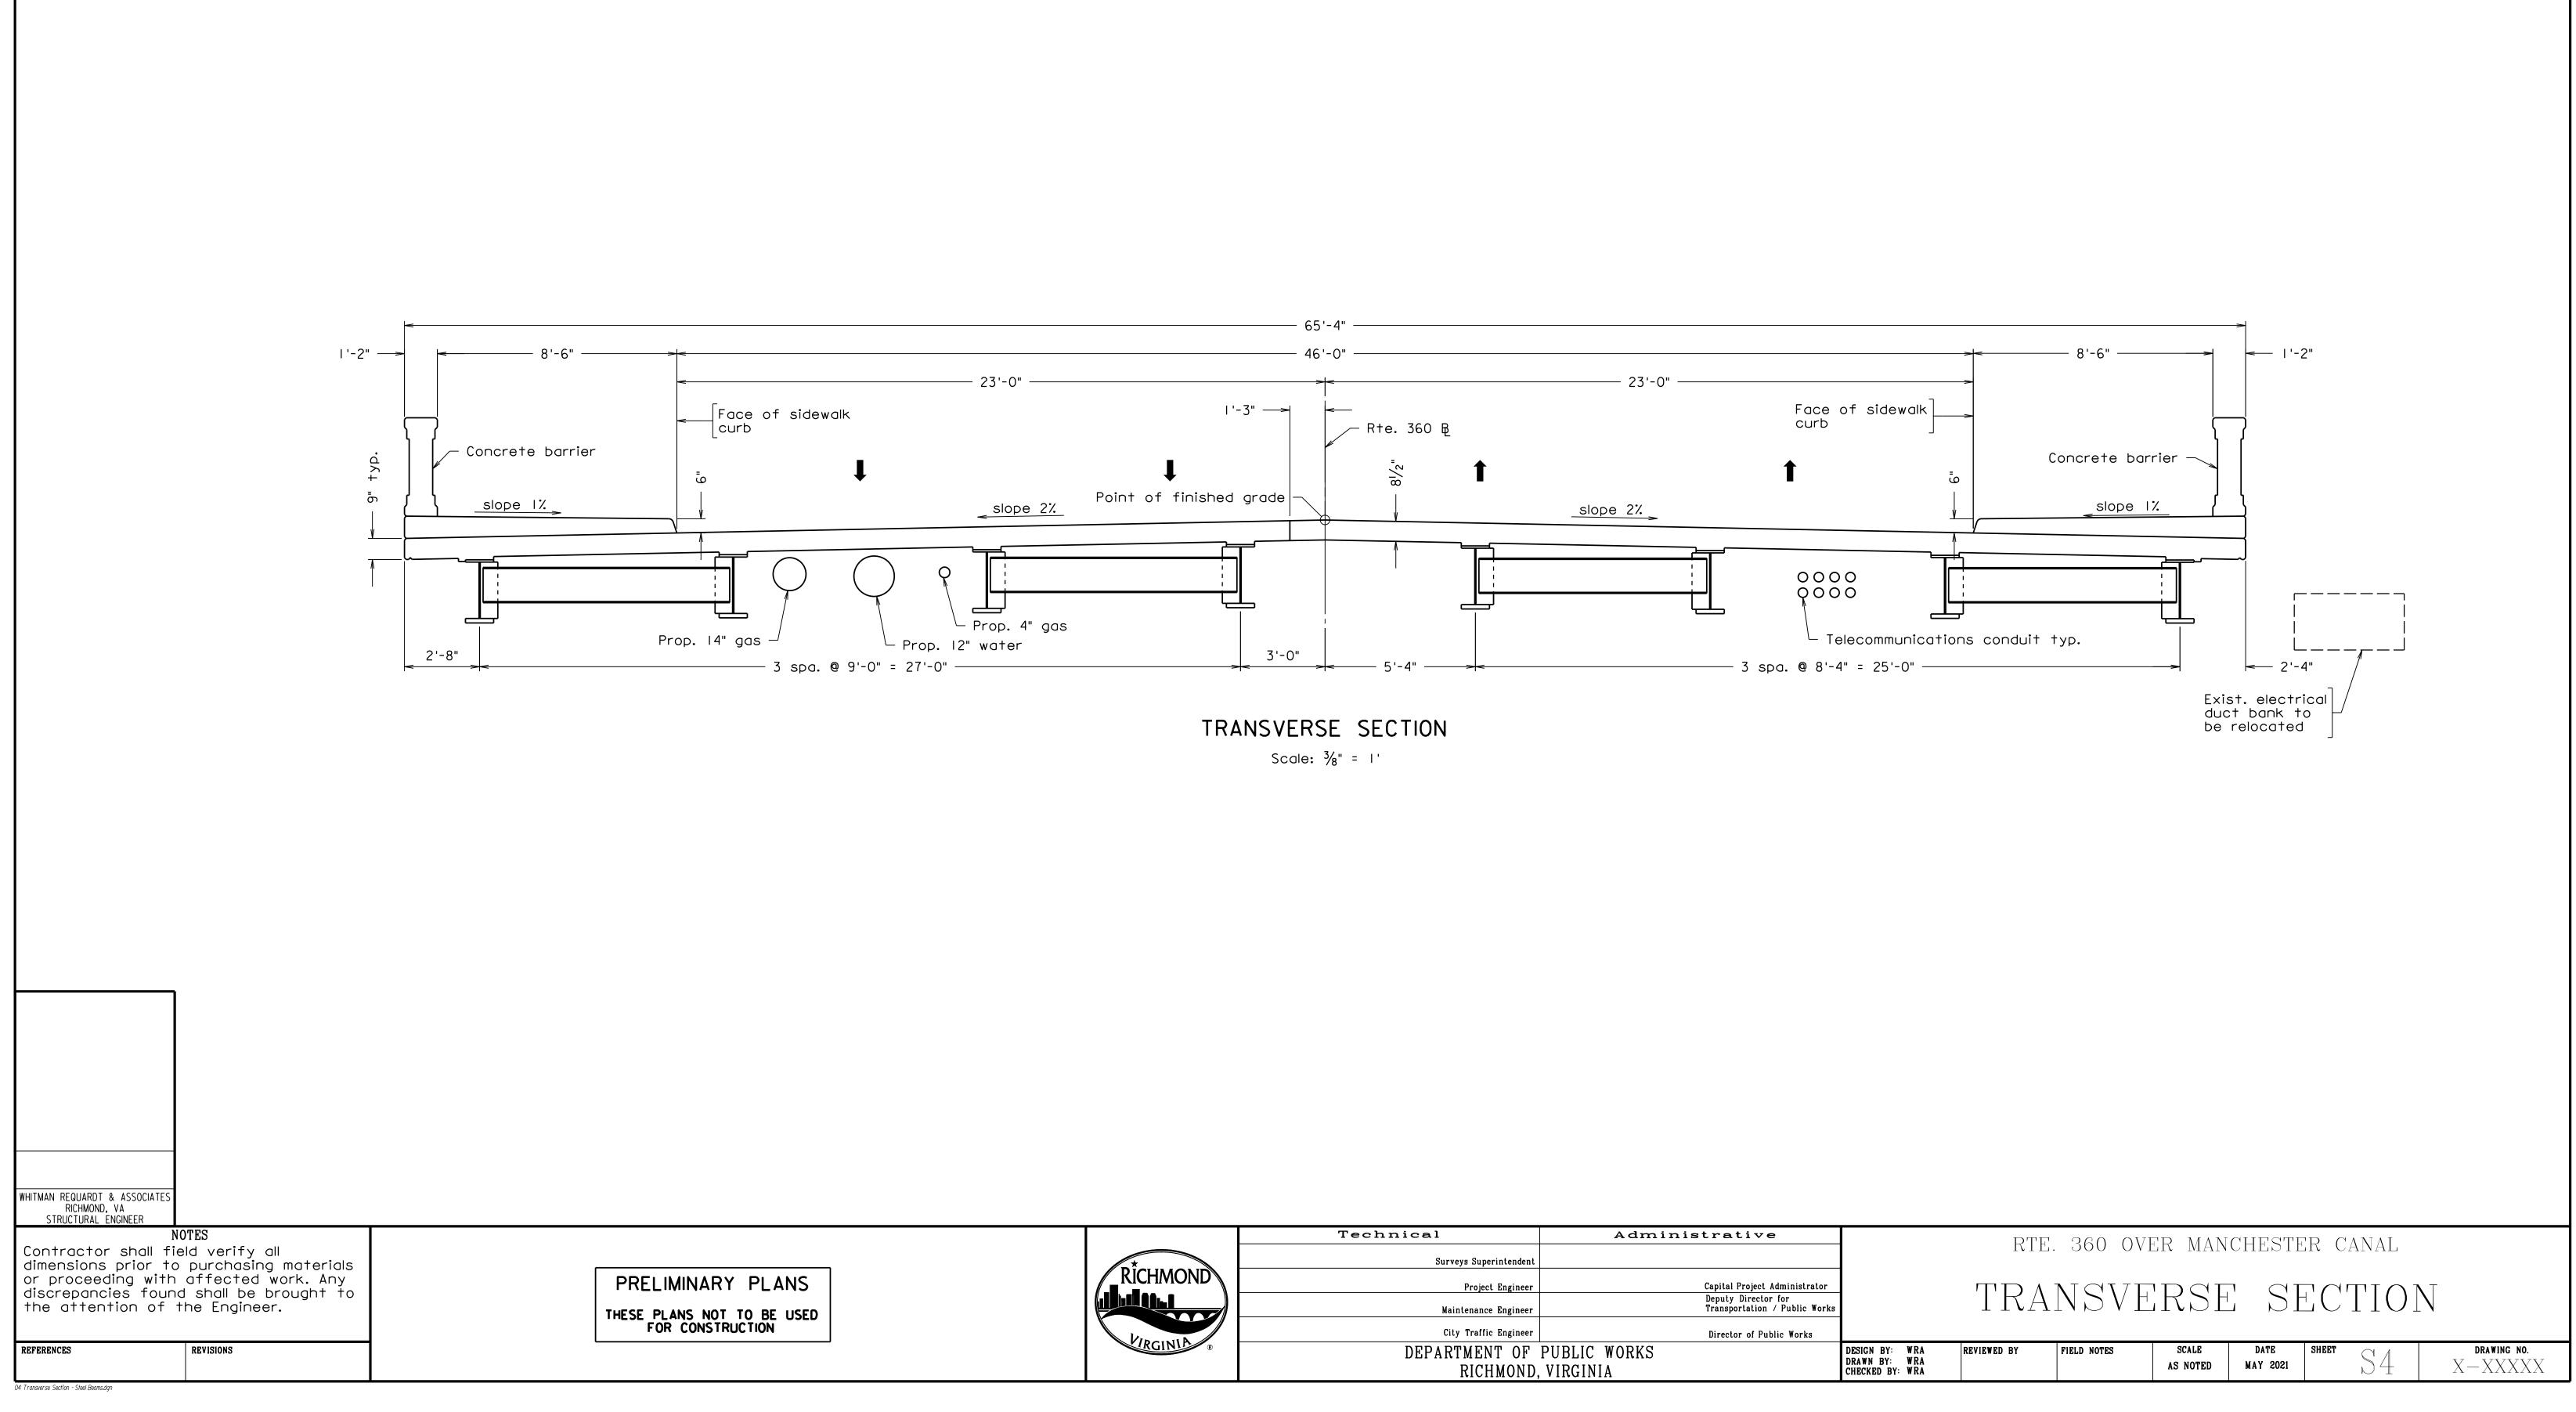


	Technical	Administrative
	Surveys Superintendent	
RÎCHMOND	Project Engineer	Capital Project Administrator
	Maintenance Engineer	Deputy Director for Transportation / Public Works
Kipawija	City Traffic Engineer	Director of Public Works
RGINIA	DEPARTMENT OF	PUBLIC WORKS
	RICHMOND,	VIRGINIA

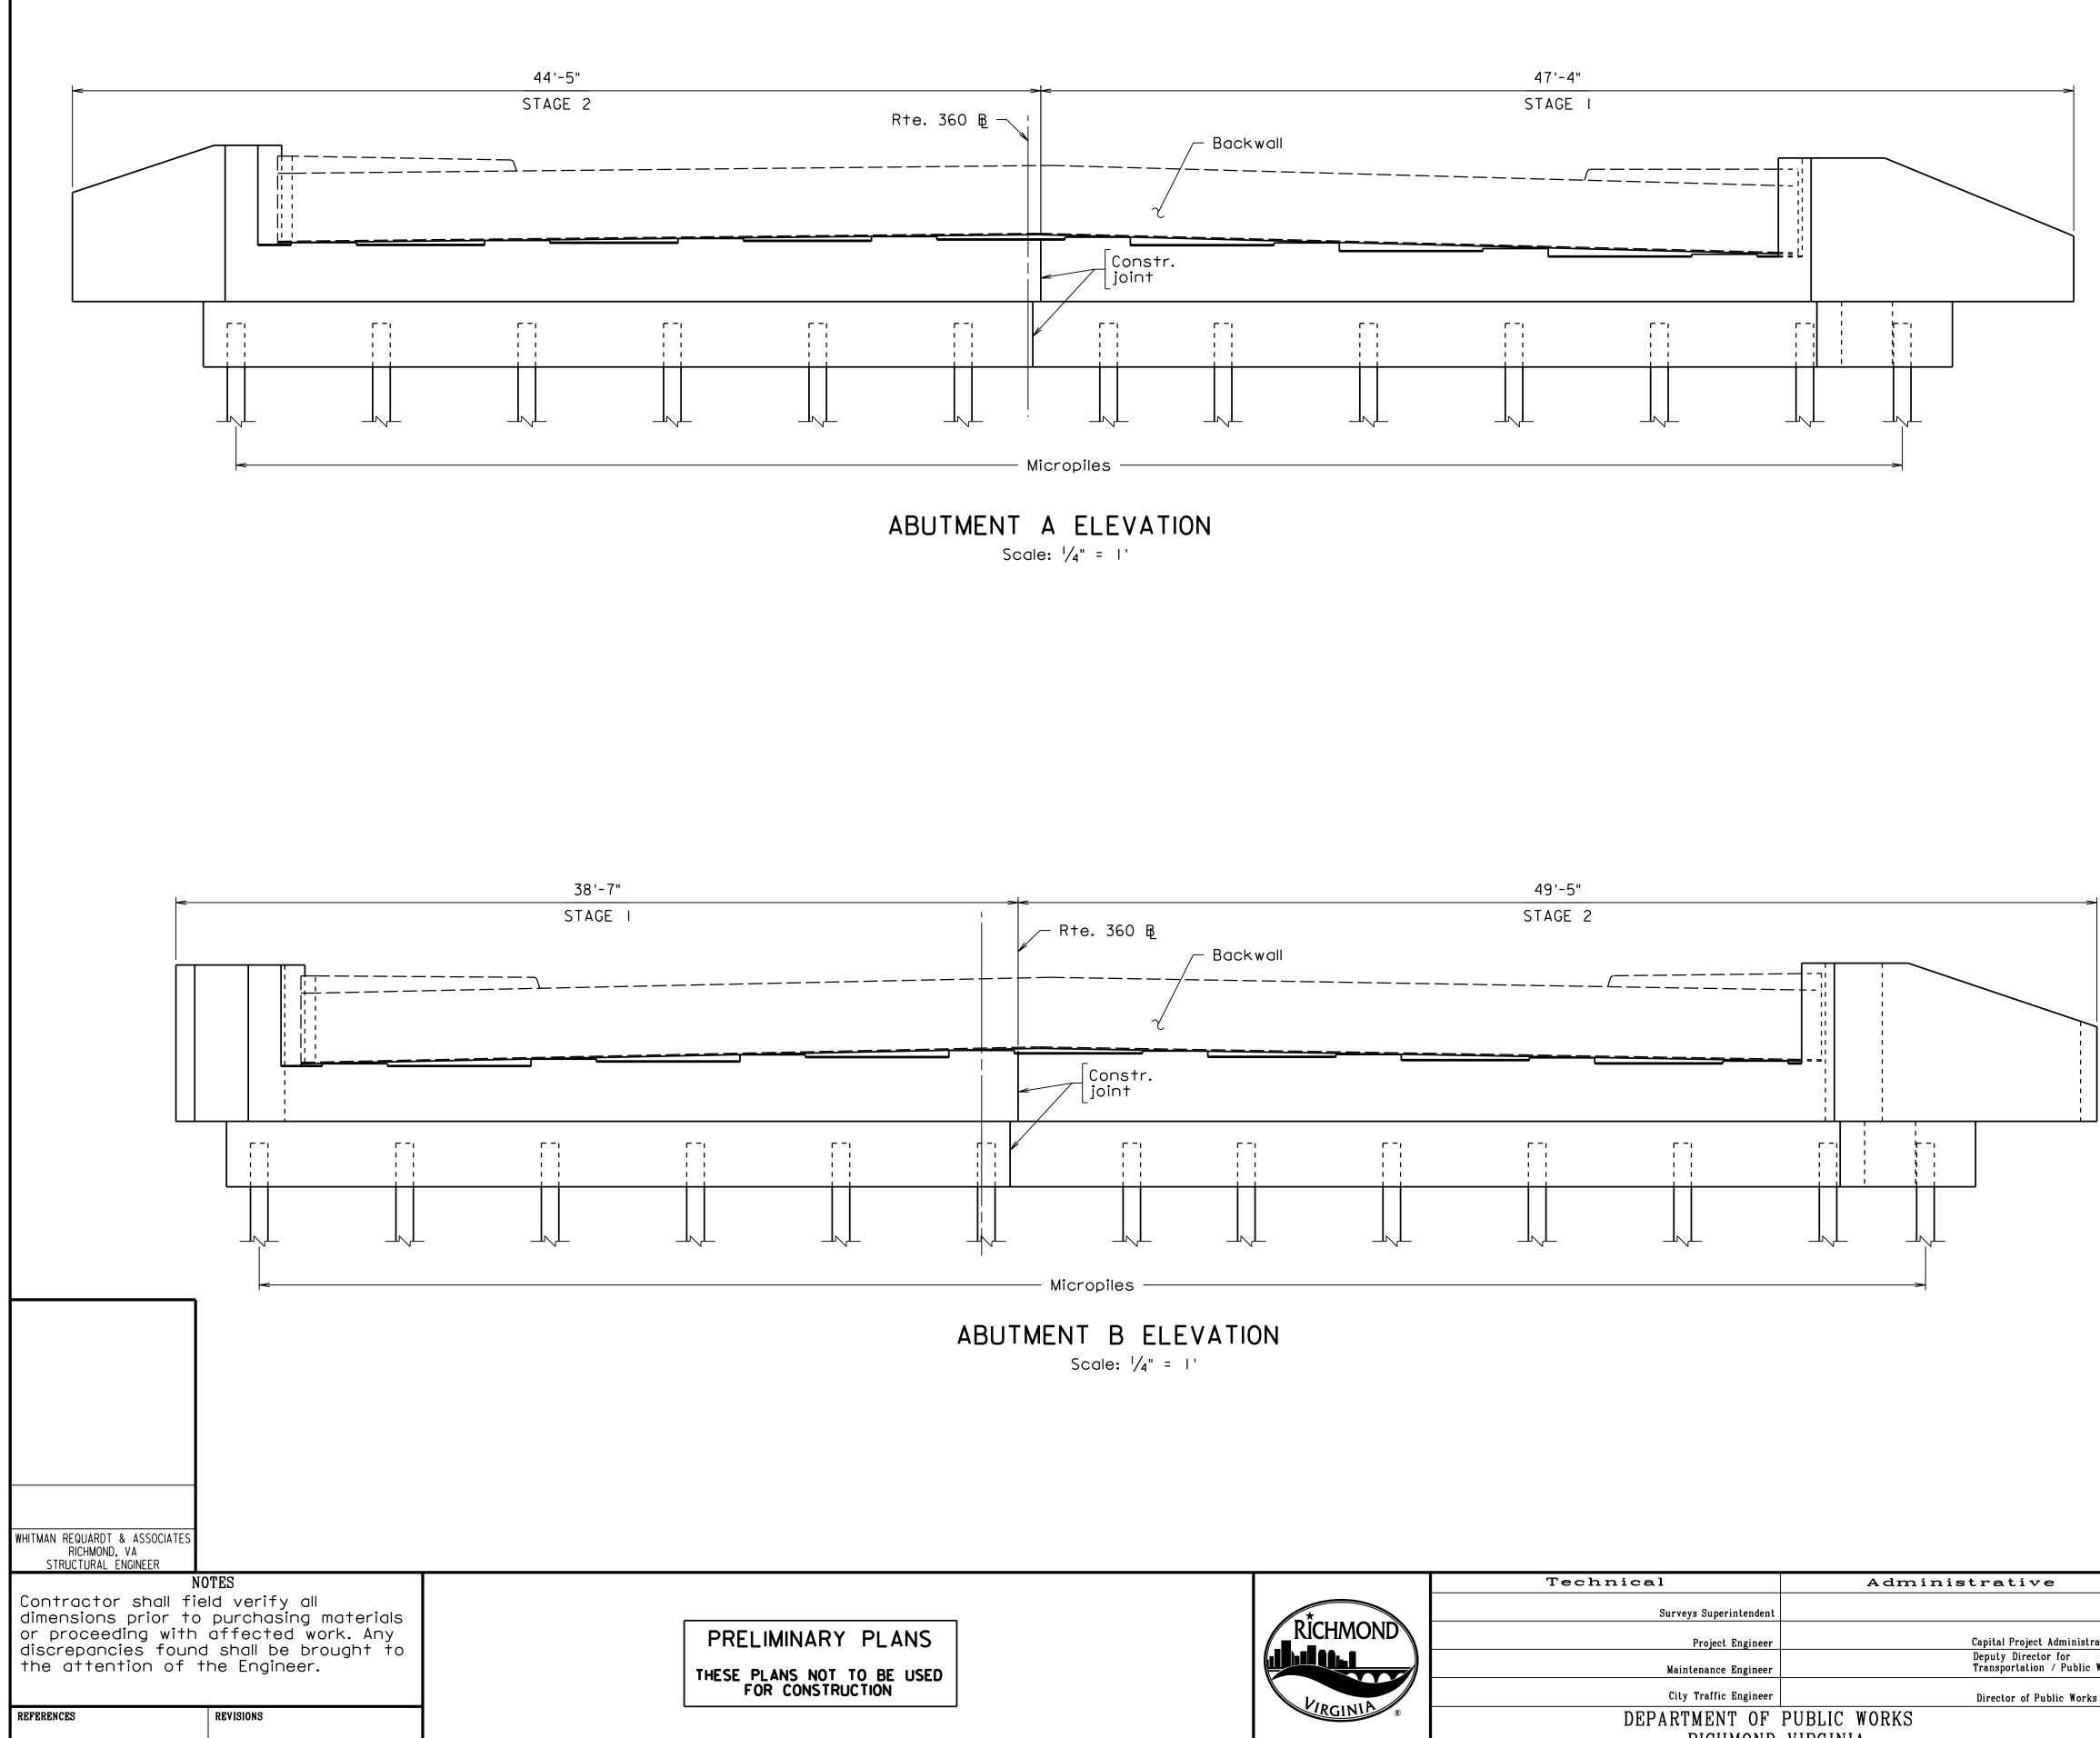


	Technical	Administrative
	Surveys Superintendent	
RÎCHMOND	Project Engineer	Capital Project Administrator
	Maintenance Engineer	Deputy Director for Transportation / Public Works
Kingentik	City Traffic Engineer	Director of Public Works
RGINIA	DEPARTMENT OF	PUBLIC WORKS
	RICHMOND,	VIRGINIA



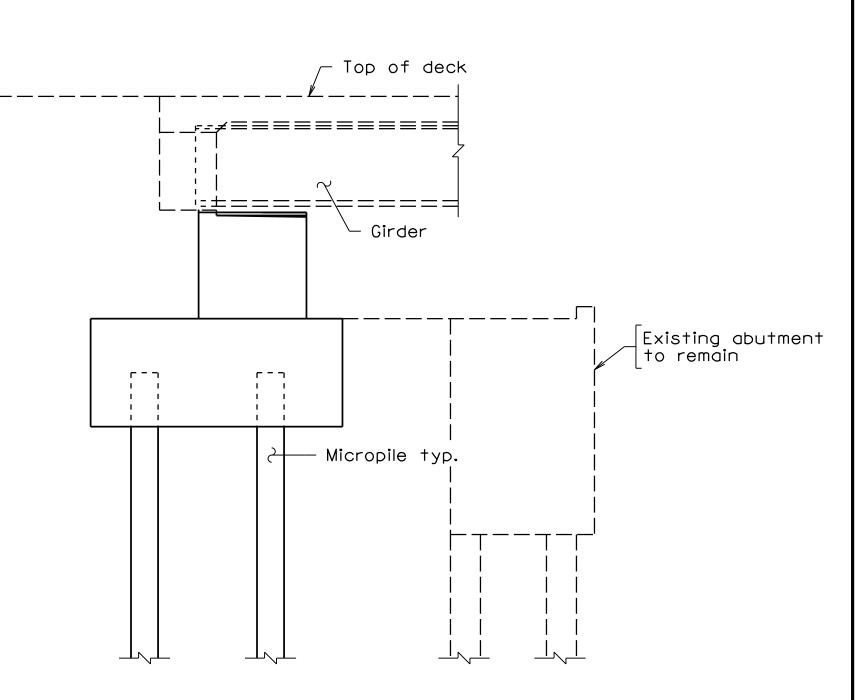

<	14'-5 ⁵ /	8"	2" >< ><	
WHITMAN REQUARDT & ASSOCIATES RICHMOND, VA STRUCTURAL ENGINEER NOTES Contractor shall field ve dimensions prior to purc or proceeding with affe discrepancies found sha the attention of the E REFERENCES			NARY PLANS S NOT TO BE USED ONSTRUCTION	

06 Barrier.dgn

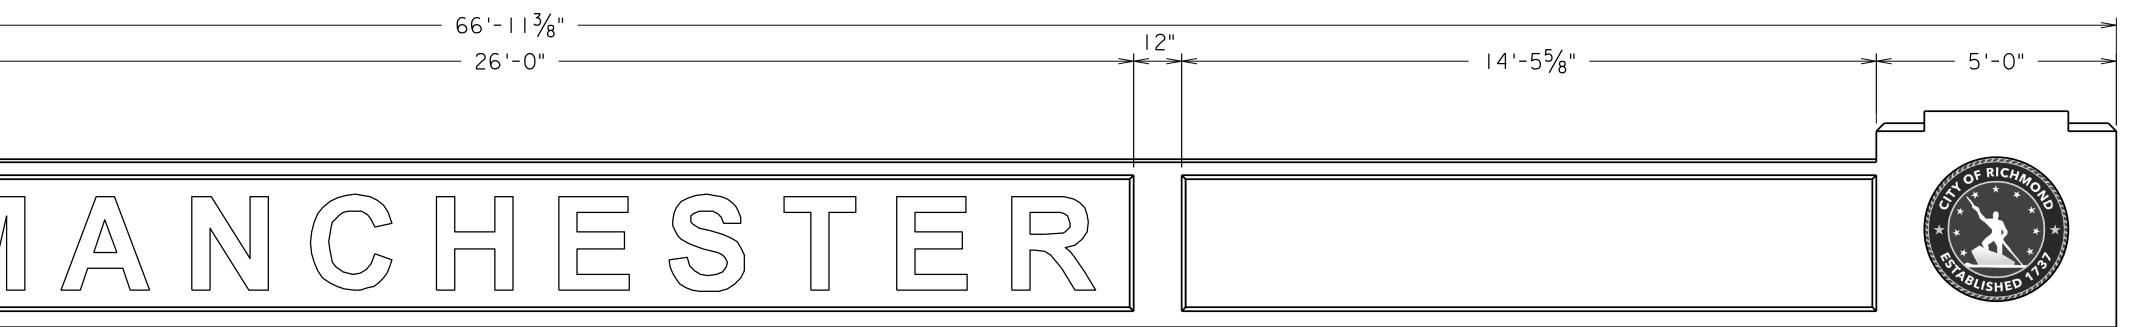



ELEVATION

Scale: 1/2" = 1'

END ALTERNATIVE #1 Scale: 1/2" = 1'


	Technical	Administrative
	Surveys Superintendent	
RÎCHMOND	Project Engineer	Capital Project Administrator
	Maintenance Engineer	Deputy Director for Transportation / Public Works
Kipewith	City Traffic Engineer	Director of Public Works
RGINITY ®	DEPARTMENT OF RICHMOND,	
		VINGINIA

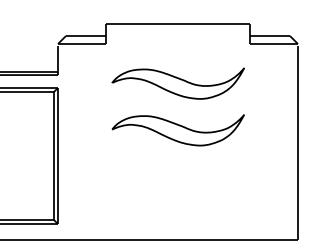

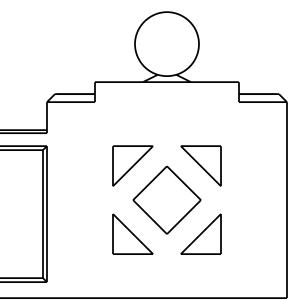

END ALTERNATIVE #2 Scale: 1/2" = 1'

(5	CONCRETE BARRIER						
	DESIGN BY: WRA DRAWN BY: WRA CHECKED BY: WRA	REVIEWED BY	FIELD NOTES	SCALE AS NOTED	DATE May 2021	sheet S6	drawing no. X—XXXXX

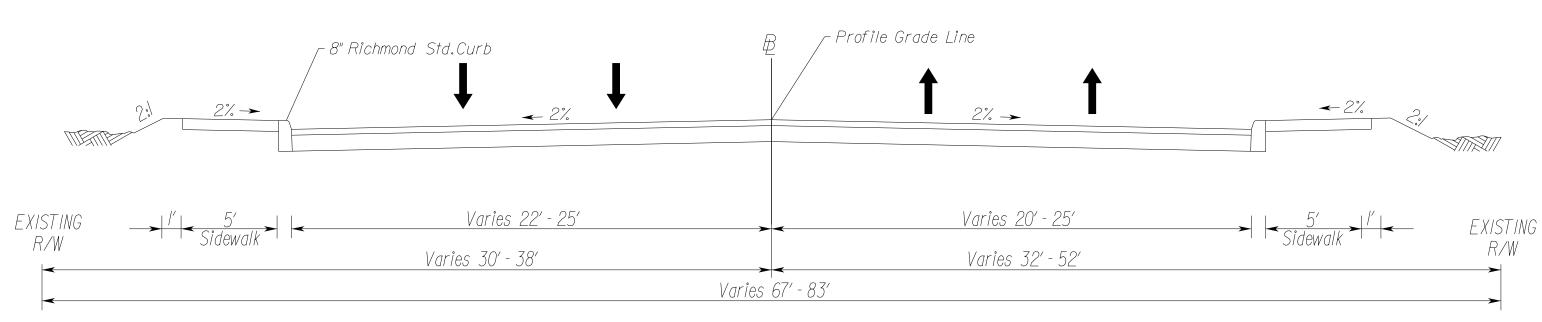

PRIVATE AND COMMERCIAL ENTRANCES

TYPE I Crusher Run Aggr. 000000

> 6" Crusher Run Aggr. 25 or 26

type II Concrete

Concrete Entrance Pavement 7" HES

4" Aggr. Base Mat'l. Ty. I No. 21B

TYPE III Asphalt

Asphalt Conc.Type SM-9.5A @ 220 Lbs. per S.Y. 4" Aggr. Base Mat'l. Ty. I No. 21B

NOT TO SCALE

type iv Asphalt Commercial

Asphalt Conc. Type SM-9.5A @ 165 Lbs. per S.Y. 4" Asphalt Conc. Base Course BM-25.0A 6" Aggr. Base Mat'l. Ty. I No. 21B

The type of entrance (I, II, III, IV) to be constructed will be determined by the existing condition at the time of construction.

NOTES	Existing Curb Curb & Gutter	-:LEGEND:- Existing Curb Cut Ramp	Proposed Conc. Sidewalk		Technical	Administrative
1. Lot dimensions in parentheses are from deed.	 Side walk 	Coping	Brick Sidewalk		Surveys Superintendent	
2. Property owners correct as of , 20	- Basin . Storm Sewer	Alley Crossing/Driveway	Castings:Water Valve ∘ <i>WV</i> • Water Meter ∘ <i>WM</i>	R ÎCHMOND		
3. Ordinance Number	 Sewer Manhole Sanitary Sewer Gravity 12"SAN. 10"SFM 	 Edge of Pavement	Gas Drip ⊂ <i>GD</i> Gas Valve ◇ <i>GV</i>		Project Engineer	Capital Project Administrator Deputy Director for
4. Adopted	Gas Line	• Cornerstone ■ • Property Pin ⊚	 Telephone Manhole O T Electric Manhole O E 		Maintenance Engineer	Transportation / Public Works
5. Accepted	 Electric Line Telephone/Telegraph T/Tg 	• Utility Pole & Proposed Sewer	Proposed Curb Cut Ramp		City Traffic Engineer	Director of Public Works
REFERENCES REVISIONS	• TV Cable CATV	· Manhole · Basin ∑ ∑	• Decorative Light •	PIRGINIA .	DEPARTMENT OF F	PUBLIC WORKS
BL: XX NW, NE, SW, SE	 Tree / Exist. Tree To Be Removed / Stump ⁽³⁾ Property Line <u>1</u> 	% / Ø . Curb & Gutter . Asphalt	 Conduit (Conc. Encased) Retaining Wall 		RICHMOND,	VIRGINIA

TYPICAL SECTIONS


HULL STREET (ROUTE 360)

STATION 11+50.94 TO STATION 13+00.55 STATION 13+62.83 TO STATION 14+97.96

FINAL TYPICAL SECTION TO BE COORDINATED WITH UPC 111703 AND POWER PLANT DEVELOPMENT

MANCHESTER ROAD

←2%

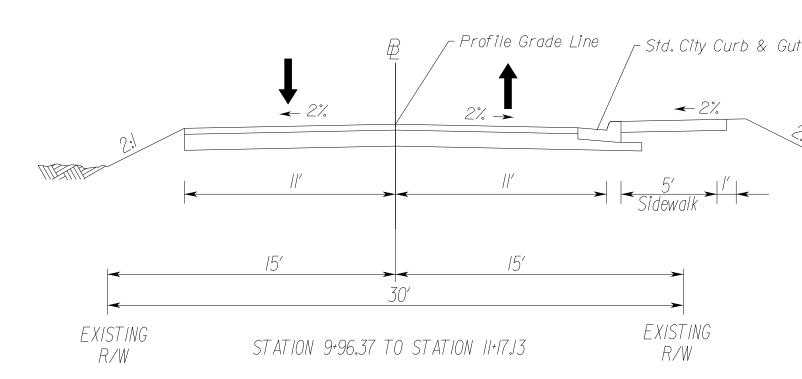



	Whitman, Requardt & Associates Richmond, Virginia ROADWAY ENGINEER
	ROADWAY ENGINEER
Curb & Gutter	
30% PLANS	
THESE PLANS ARE UNFINISHED AND UNAPPROVED AND ARE NOT	
TO BE USED FOR ANY TYPE OF CONSTRUCTION OR THE	
ACQUISITION OF RIGHT OF WAY.	

RTE. 360 OVER MANCHESTER CANAL

TYPICAL SECTIONS

DESIGN BY: GGK DRAWN BY: AD CHECKED BY: MSV REVIEWED BY FIELD NOTES SCALE DATE 1"-25' MAY 2021 SHEET 2A DRAWING NO. X-XXXXX	CIP:XXX-XXX-XXXX				
	DRAWN BY: AD	REVIEWED BY	FIELD NOTES		drawing no. X—XXXXX

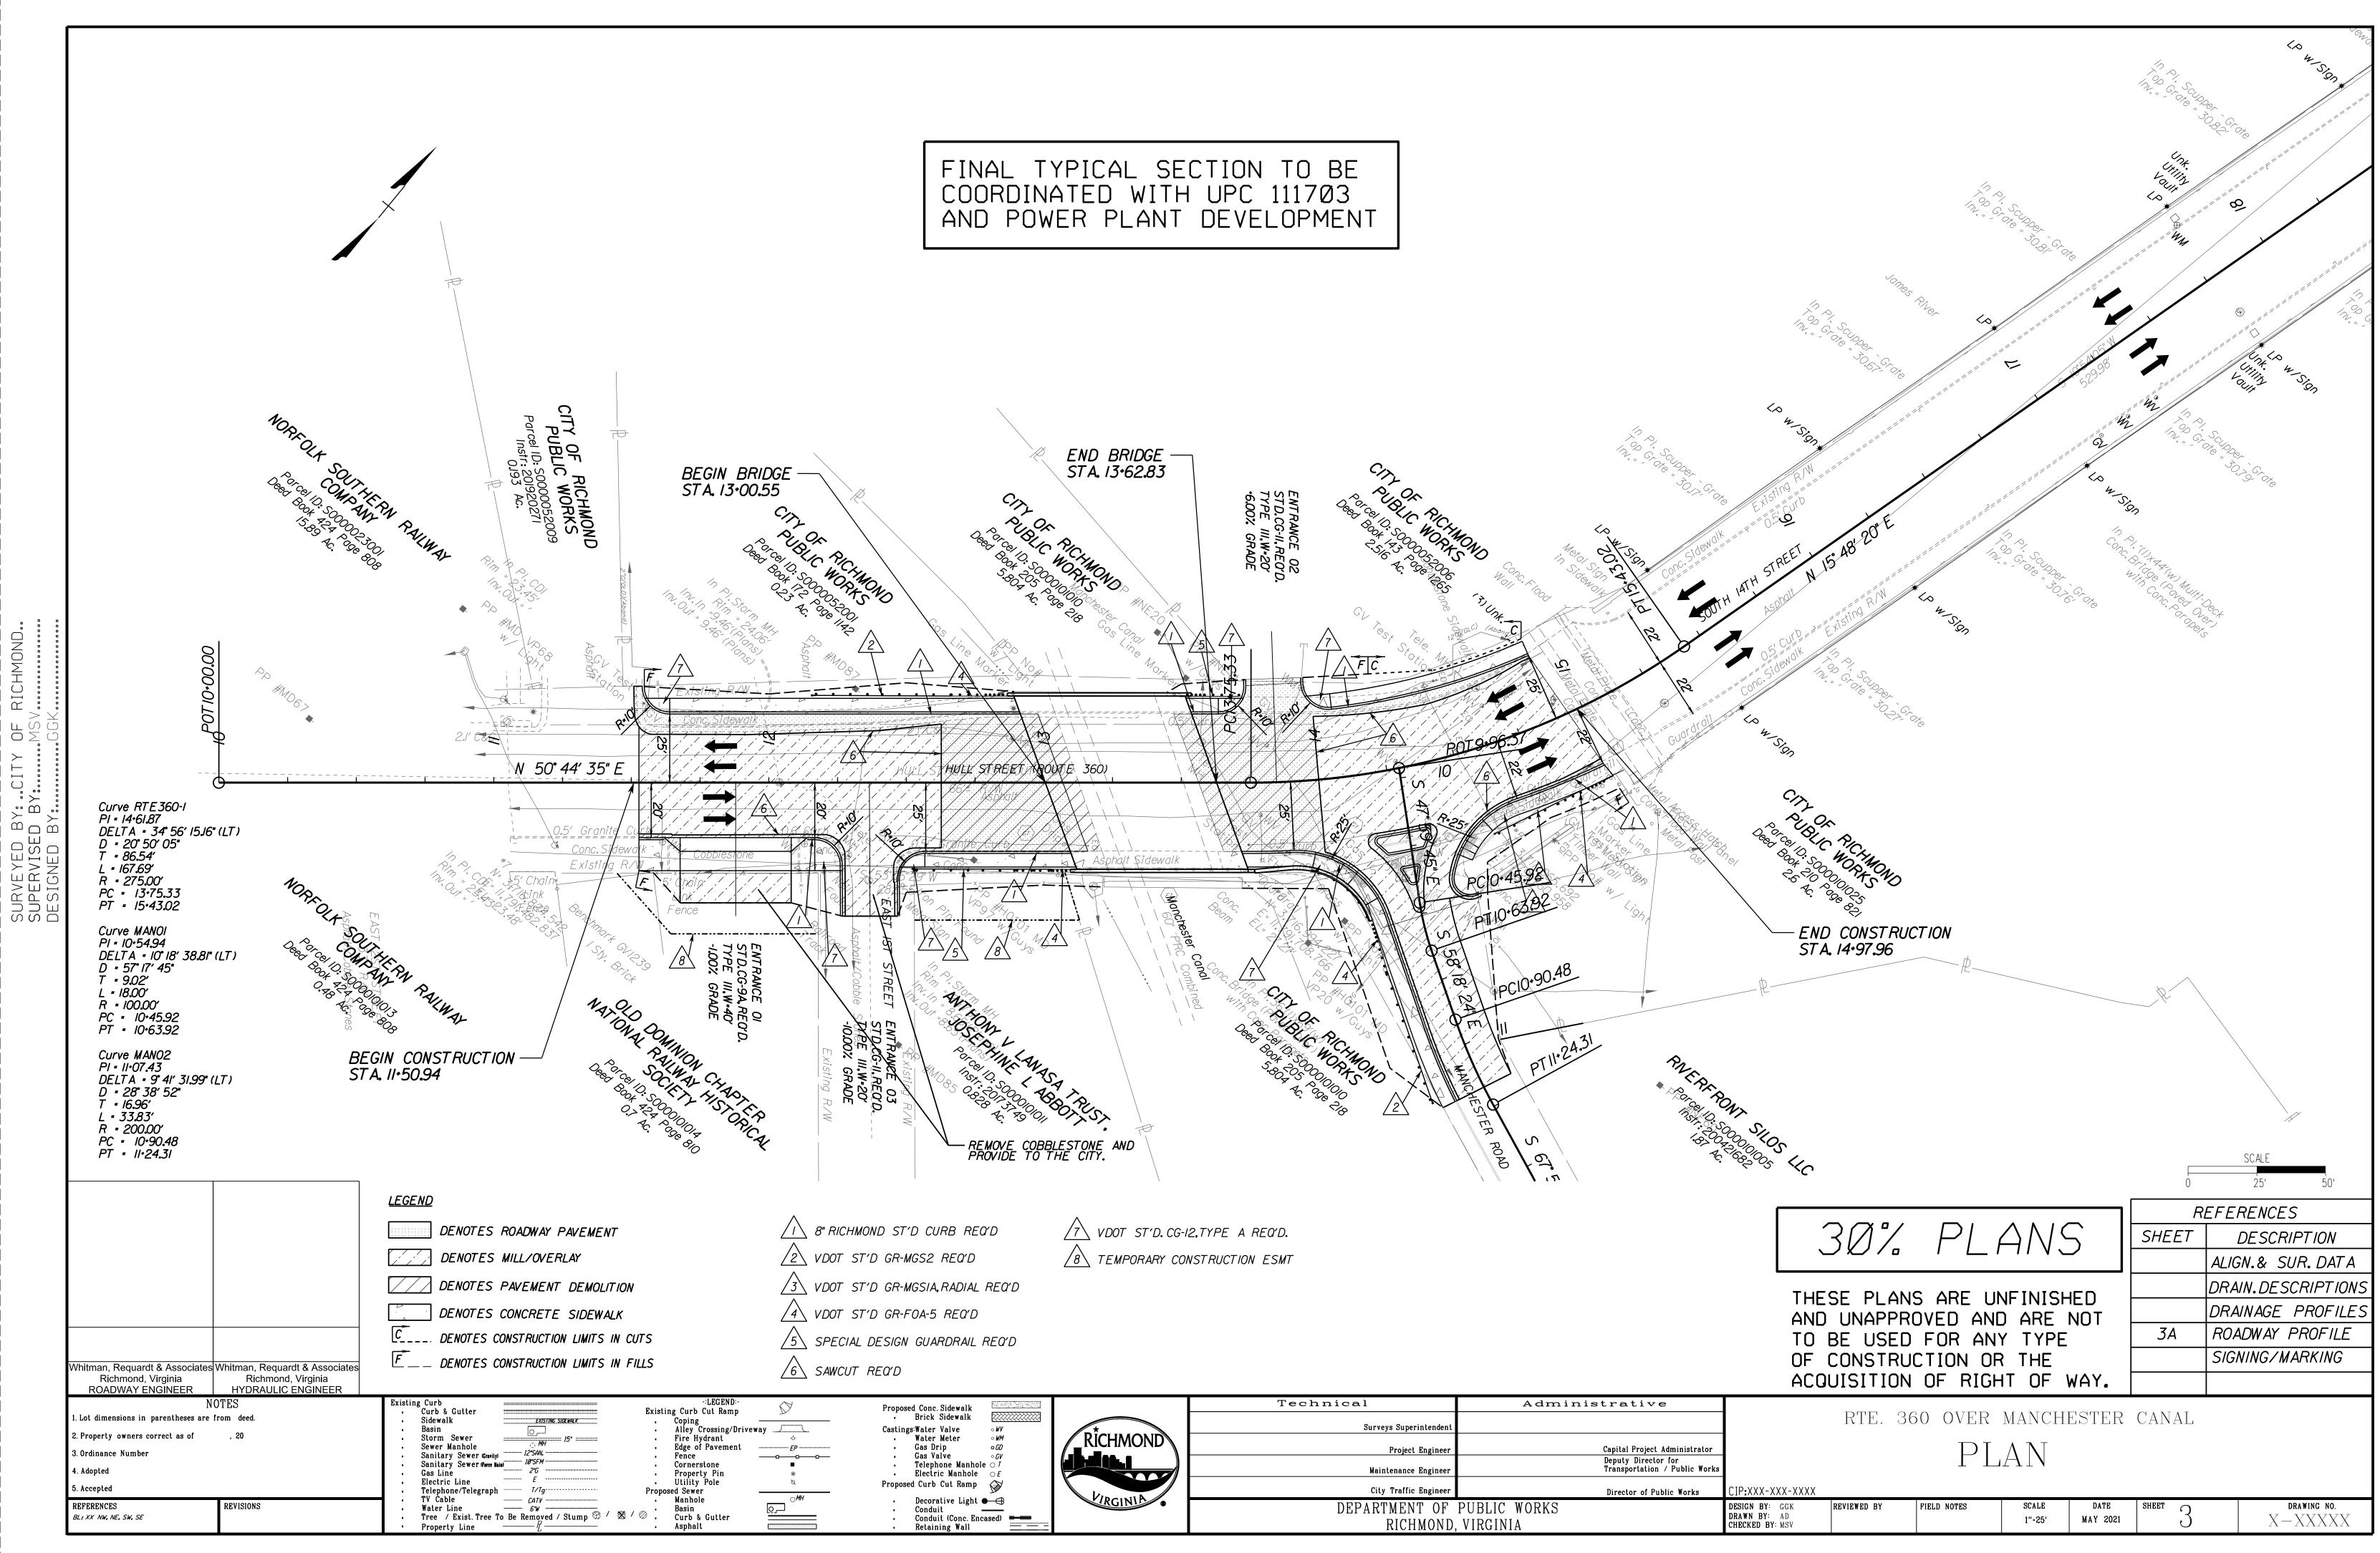

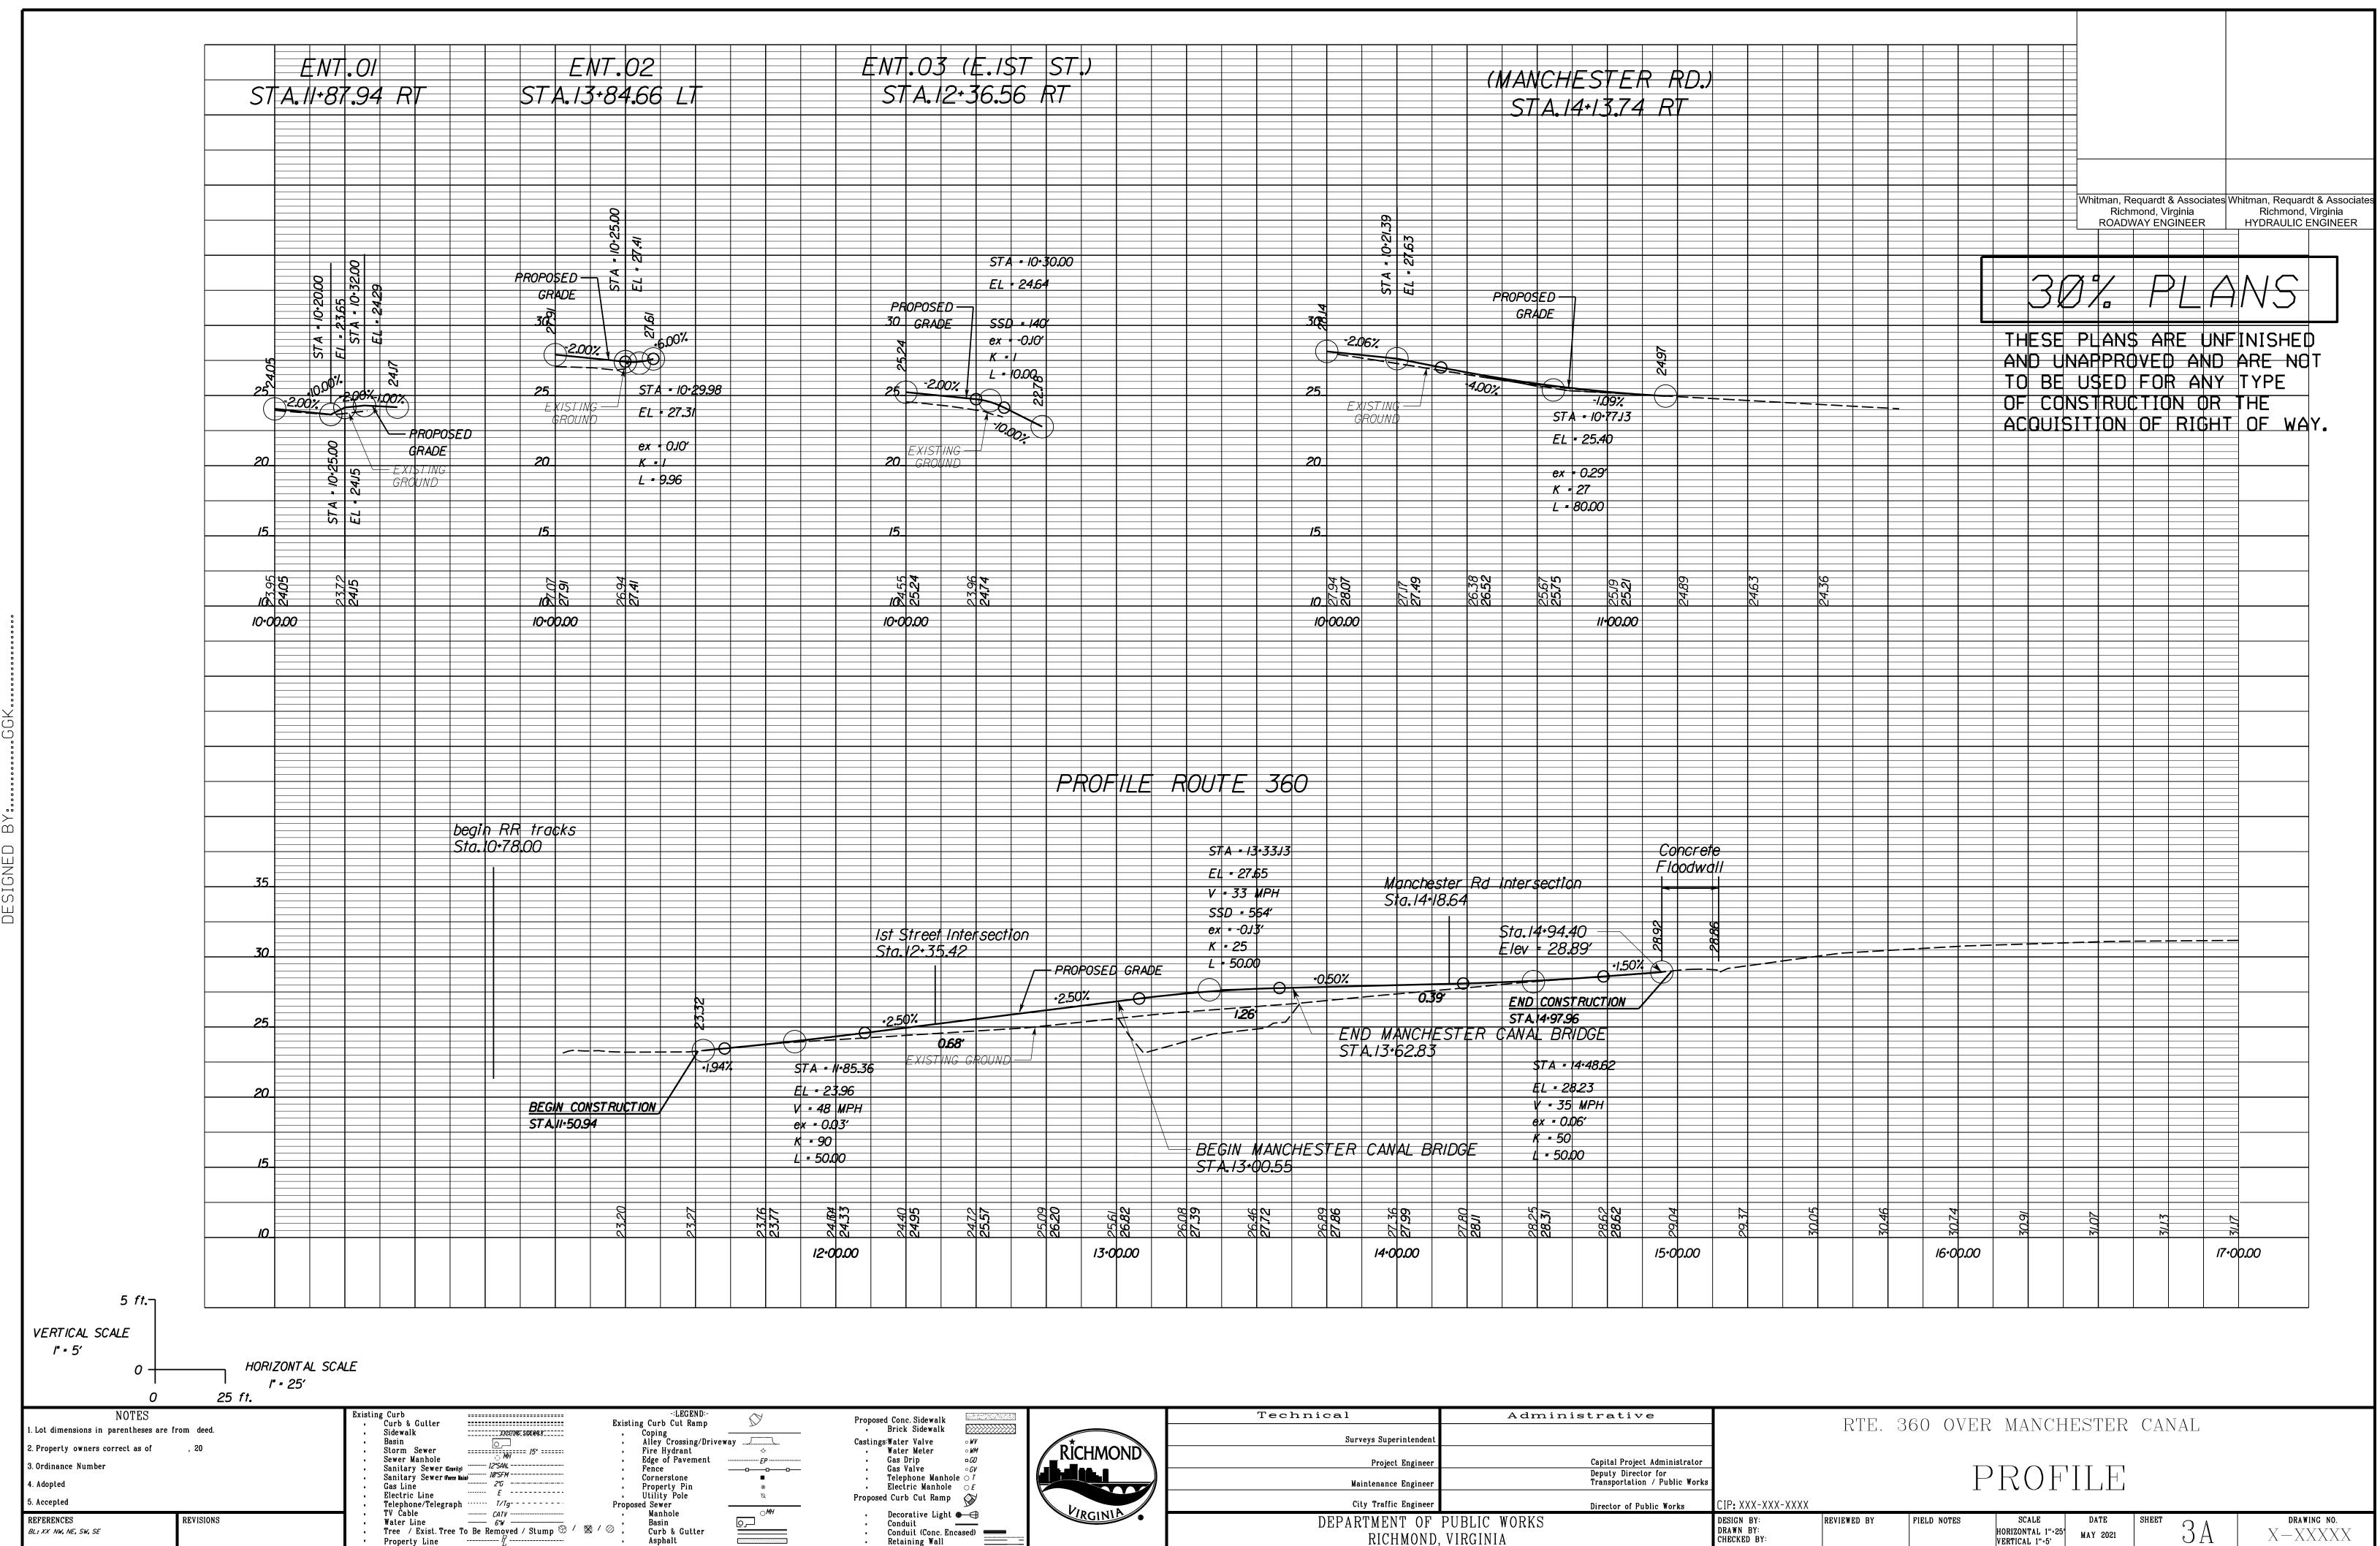

BY: CITY OF RICHMOND. D BY: MSV. BY: GGK. SURVEYED SUPERVISEI DESIGNED

Property Line

Asphalt

Proposed Conc. Sidewalk		Technical	Administrative
Brick Sidewalk		Surveys Superintendent	
Castings:Water Valve o WV		Surveys Superintendent	
∎ Water Meter ∘ <i>WM</i>	RICHMOND		
• Gas Drip □ <i>GD</i>		Project Engineer	Capital Project Administrator
▪ Gas Valve ∘ <i>GV</i>	▏《▁▆▉▙▅▋▅▅▖▅ \ ▌		Deputy Director for
• Telephone Manhole O 7		Maintanana Businsan	Transportation / Public Worl
 Electric Manhole OE 		Maintenance Engineer	
Proposed Curb Cut Ramp 🛛 🔊			
		City Traffic Engineer	Director of Public Works
• Decorative Light 🏶 🕀	VIRGINIA .		
- Conduit -		DEPARTMENT OF	PUBLIC WORKS
 Conduit (Conc. Encased) 			
• Retaining Wall		RICHMOND,	VIKGINIA

CHECKED BY:

VERTICAL 1"-5'